

VILLAGE OF VERNON HILLS

ORDINANCE NO. 2011-037

AN ORDINANCE AMENDING THE FINAL SITE AND LANDSCAPING PLAN
APPROVALS FOR THE PROPOSED EAST PARKING LOT EXPANSION PLAN FOR
PROPERTY LOCATED AT 11 EAST HAWTHORN PARKWAY, IN THE VILLAGE OF
VERNON HILLS, LAKE COUNTY

THE 6TH DAY OF JULY, 2011

Published in pamphlet form by the Authority of the
President and Board of Trustees of the Village of
Vernon Hills, Lake County, Illinois, this 12th Day
of July, 2011

ORDINANCE NO. 2011-037

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SITE AND LANDSCAPING PLAN
APPROVALS FOR THE PROPOSED EAST
PARKING LOT EXPANSION PLAN FOR
PROPERTY LOCATED AT 11 EAST
HAWTHORN PARKWAY, IN THE VILLAGE
OF VERNON HILLS, LAKE COUNTY**

WHEREAS, Eugene Childers representing Rust-Oleum Corporation, in regard to properties legally described in Exhibit A, has petitioned the Village of Vernon Hills, pursuant to Vernon Hills Zoning Ordinance of 1982, as amended, to approve an amendment to the final site and landscaping plans to allow the proposed addition to the existing east parking lot located at 11 East Hawthorn Parkway.

WHEREAS, Rust-Oleum Corporation is proposing to expand the existing parking lot to add an additional 11 parking spaces to the visitor parking lot located at the front entrance of the building.

NOW, THEREFORE, BE IT ORDAINED BY THE PRESIDENT AND BOARD OF TRUSTEES OF THE VILLAGE OF VERNON HILLS, COUNTY OF LAKE AND STATE OF ILLINOIS:

SECTION I. Pursuant to the Vernon Hills Zoning Ordinance of 1982, as amended, the amendments to the final site and landscaping plans to allow the proposed addition to the existing east parking lot located at 11 Hawthorn Parkway are hereby approved; said plans are attached as Exhibits B and may be amended subject to the following conditions:

- A. **General compliance with the following plans:**
1. Engineering improvement plans for the East Parking Lot Expansion prepared by Pearson, Brown & Associates, Inc consisting of 5 pages with a revised date of May 23, 2011.
 2. Landscape Plan prepared by Western DuPage Landscaping, Inc consisting of 1 page with a date of May 23, 2011. It is understood that these plans may be amended to address concerns with screening the parking lot and the loss of two hawthorn trees. The two trees shall be replaced with similar type trees within either Parcels 1 or 2. Due to concerns with plant disease, special attention will be paid to the types of pine trees placed on the property.
- B. As may be required by the Village Engineer, the petitioner may be required to provide a photometric plan for the project. Additional parking lot lighting may be required if, in the opinion of the Village Engineer, the lot fails to meet with requirements of the Development Ordinance.
- C. Final approval of plans by the Village Engineer and Landscape Architect.
- D. Compliance with all ordinances and standards of the Village.

SECTION II. SEVERABILITY. In the event that any section, clause, provision, or part of this ordinance shall be found and determined to be invalid by a court of competent jurisdiction, all valid parts that are severable from the invalid parts shall remain in full force and effect. If any part of this ordinance is found to be invalid in any one or more of its several applications, all valid applications that are severable from the invalid applications shall remain in effect.

SECTION III. REPEAL AND SAVINGS CLAUSE. All ordinances or parts of ordinances in conflict herewith are hereby repealed; provided, however, that nothing herein contained shall affect any rights, actions or causes of action which shall have accrued to the Village of Vernon Hills prior to the effective date of this ordinance.


SECTION IV. EFFECTIVE DATE. This ordinance shall be in full force and effect from and after its passage, approval and publication as provided by law.

SECTION V. ORDINANCE NUMBER. This ordinance shall be known as Ordinance Number 2011-037.

AYES: 6 – Marquardt, Koch, Schultz, Williams, Hebda, Schwartz

NAYS: 0 - None

ABSENT AND NOT VOTING: 0 - None

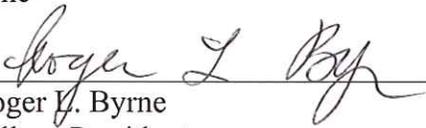

Roger V. Byrne
Village President

PASSED: 07/06/2011

APPROVED: 07/06/2011

PUBLISHED IN PAMPHLET FORM: 07/12/2011

ATTEST:



Michael Allison
Village Clerk

Exhibit A
Legal Description

POND CONSTRUCTION, REPAIR, REPLACEMENT
AND MAINTENANCE AGREEMENT

THIS AGREEMENT made this 26th day of October, 1978, by and between THE VERNON HILLS PARK DISTRICT, an Illinois municipal corporation (the "District") and RUST-OLEUM CORPORATION, an Illinois corporation ("Rust-Oleum"):

W I T N E S S E T H:

THAT WHEREAS, Rust-Oleum is the owner of certain property in Vernon Hills, Illinois upon which it has constructed its international headquarters building, said property legally described as follows (the "Headquarters Property"):


Sublots 1 and 2 in the Resubdivision of Lot 3 in New Century Town Unit One, being a subdivision of parts of Sections 32 and 33, Township 44 North, Range 11, East of the Third Principal Meridian, in Lake County, Illinois, according to the Plat thereof, recorded on December 3, 1976 as Document No. 1807720.

AND WHEREAS, the District owns property east of and adjacent to the Headquarters Property, which property owned by the District is used as a water course pursuant to an easement granted to the Seavey Slough Drainage District by document recorded on February 6, 1911 as Document No. 133623 with the Recorder of Deeds of Lake County, Illinois and which property is described as follows (the "District Property"):

Lot 2 in New Century Town Unit One, being a subdivision of parts of Sections 32 and 33, Township 44 North, Range 11, East of the Third Principal Meridian, in Lake County, Illinois, according to the Plat thereof, recorded on December 3, 1976 as Document No. 1807720.

AND WHEREAS, Rust-Oleum has offered to the District to improve and beautify the District Property through the installation, landscaping and maintenance in the District Property of certain pond improvements (the "Improvements") shown on plans (the "Plans") prepared by C. F. Murphy Associates, 224 South Michigan Avenue, Chicago, Illinois entitled "Rust-Oleum Corporation International Headquarters, Vernon Hills, Illinois - Job No. 3700 dated July 5, 1978," containing

Exhibit B
Plans

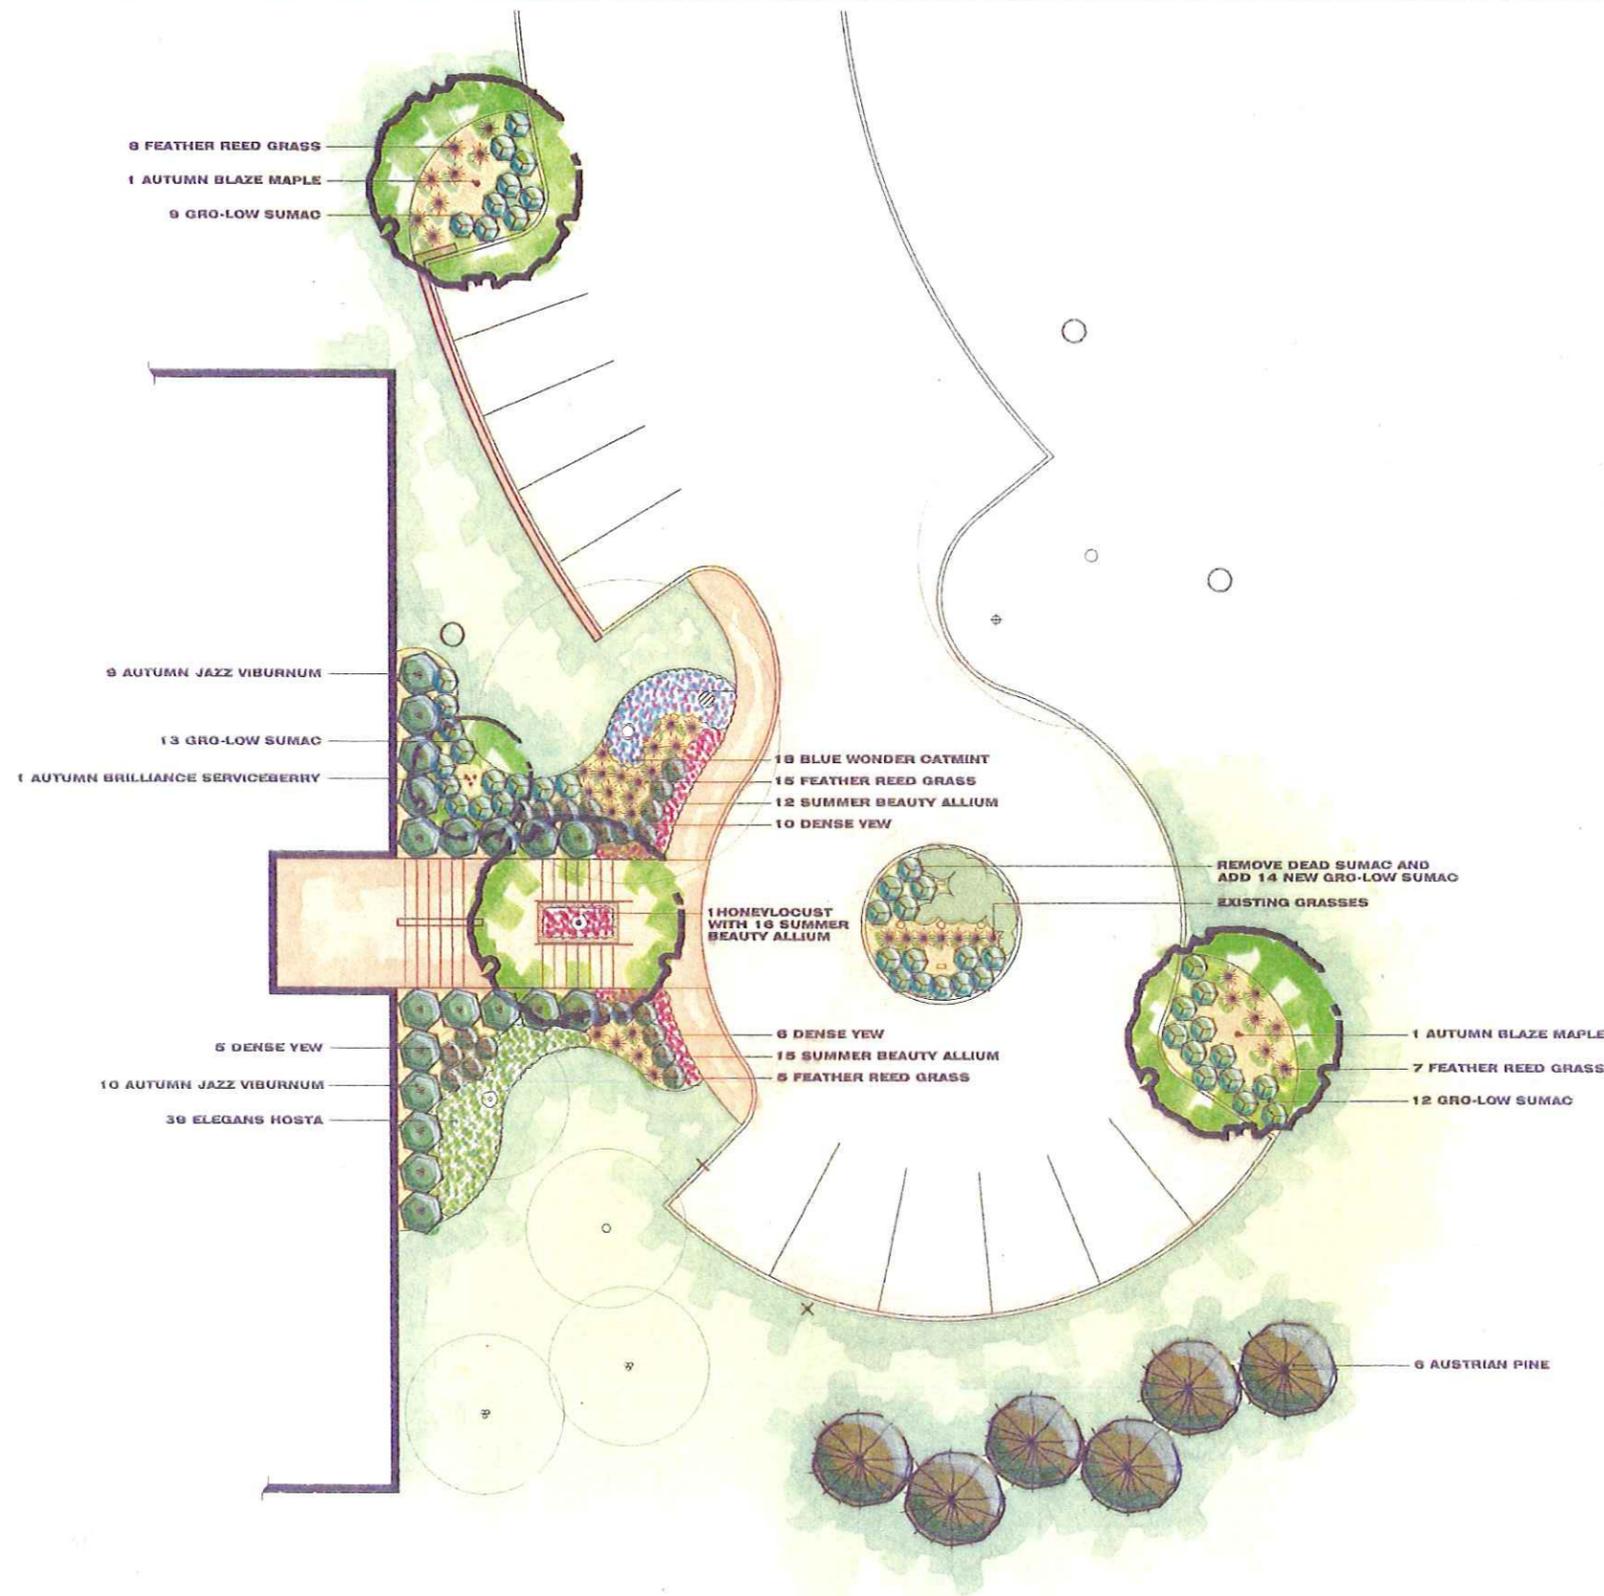

Landscape Development Plan

RUST-OLEUM CORPORATION

Hawthorn Parkway
Vernon Hills, Illinois

sheet:
date: 23 MAY 2011
project no.:

Drawn: TM
Checked: MH
scale: 1"=10'-0"

north:

RECEIVED

MAY 25 2011


COMMUNITY DEVELOPMENT
DEPARTMENT

revisions:

RUST-OLEUM

EAST PARKING LOT EXPANSION

VERNON HILLS, ILLINOIS

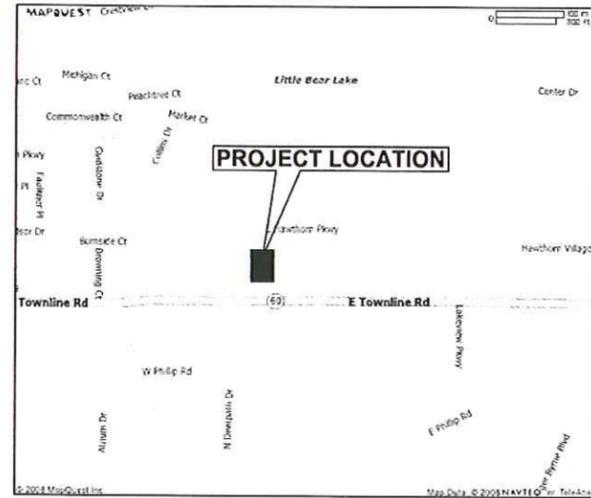

LOCATION MAP NORTH

BENCHMARKS:

NORTHWEST FLANGE BOLT ON FIRE HYDRANT LOCATED LAKEVIEW PARKWAY +/- 350' NORTH OF THE INTERSECTION OF LAKEVIEW PARKWAY AND HAWTHORN PARKWAY ELEVATION = 690.89 (NGVD 88)

INDEX

1. COVER SHEET
2. EXISTING CONDITIONS PLAN
3. GEOMETRICS PLAN
4. GRADING PLAN W/ EROSION CONTROL
5. DETAILS

LEGEND

EXISTING	PROPOSED	EXISTING	PROPOSED	
				CENTER LINE
				EASEMENT
				BUILDING SETBACK
				CURB & GUTTER
				CURB & REVERSE GUTTER PITCH
				DEPRESSED CURB & GUTTER
				GUARD RAIL
				FENCE
				RETAINING WALL
				CURB RAMP
				DRIVEWAY HAND
				SIGN
				MAIL BOX
				SOIL BORING
				DECIDUOUS TREE, DIAMETER
				EVERGREEN TREE, HEIGHT
				TOP OF FOUNDATION
				FINISHED GRADE
				SPOT ELEVATION
				TOP OF CURB ELEVATION
				FLOW LINE OF GUTTER
				CONTOUR
				DITCH
				DRAINAGE FLOW
				OVERLAND FLOW
				RIM ELEVATION
				INVERT ELEVATION
				WETLAND LIMIT
				WETLAND BUFFER LINE
				RIDGE LINE
				BASE FLOOD ELEVATION LINE
				F.E.M.A. FLOODPLAIN LINE

GENERAL CONTRACTOR:



2801 LAKESIDE DRIVE - SUITE 200 BANNOCKBURN, IL. 60015 (847) 615-1515

CONSULTING ENGINEERS:



A PROFESSIONAL DESIGN FIRM - ILLINOIS PROFESSIONAL ENGINEERING CORPORATION - LICENSE NUMBER 184-001058. EXPIRES 04/30/13
1850 W. WINCHESTER ROAD - SUITE 205 LIBERTYVILLE, IL. 60048 (847) 387-6707

NOT FOR CONSTRUCTION



CALL JULIE 1-800-892-0123
WITH THE FOLLOWING:
COUNTY: LAKE
CITY/TOWNSHIP: VERNON HILLS / T44N R11E
SEC. & 1/4 SEC. NO.: SEC 33, SW. 1/4
48 Hours Before You Dig
EXCLUDING SAT., SUN. & HOLIDAYS


PERMIT VILLAGE	NUMBER	DATE ISSUED

REVISIONS	
1	05/23/11 REVISED SIDEWALK PER OWNER
2	
3	
4	
5	
6	
7	
8	
9	
10	
11	
12	

ENGINEER'S SEAL & SIGNATURE

ORIGINAL ISSUE DATE: 05/20/11
SHEET NUMBER 1
OF 5 SHEETS

RUST-OLEUM EAST PARKING LOT EXPANSION

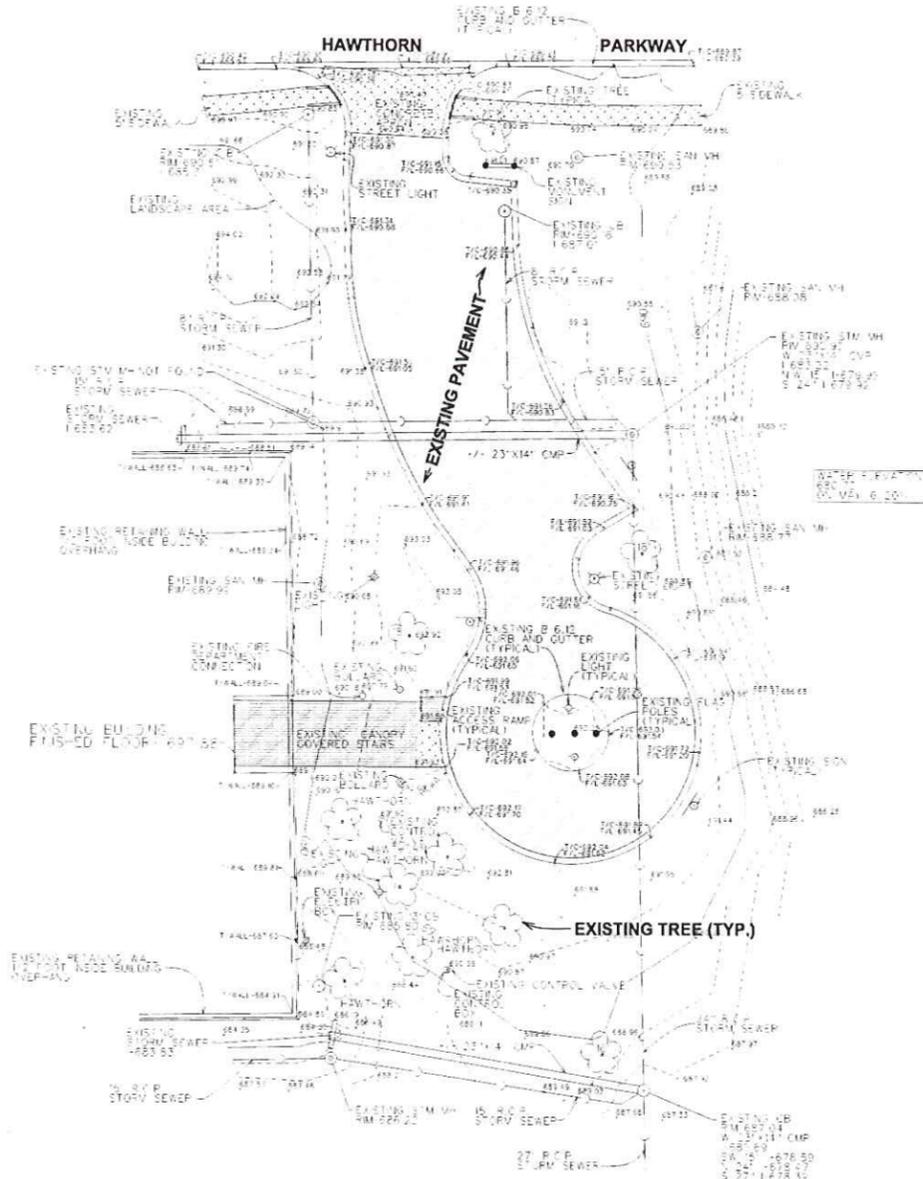

RUST-OLEUM CORPORATION
VERNON HILLS, ILLINOIS

PEARSON, BROWN & ASSOCIATES, INC.
CONSULTING ENGINEERS
1850 W. WINCHESTER ROAD - SUITE 205
LIBERTYVILLE, ILL. 60466
PHONE: (647) 367-3407
FAX: (647) 367-3407
E-MAIL ADDRESS: pba@pearsonbrown.com

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DESIGNED BY: G.A.Z.
DRAWN BY: R.C.L.
CHECKED BY: J.F.C.
ORIGINAL ISSUE: 05/20/11



DATE BY	DESCRIPTION

EXISTING CONDITIONS PLAN

Principle
1801 Lakeside Drive, Suite 300
Rolling Meadows, IL 60015
630.581.1000

SHEET NUMBER
2
OF 5 SHEETS

JOB No. 1124

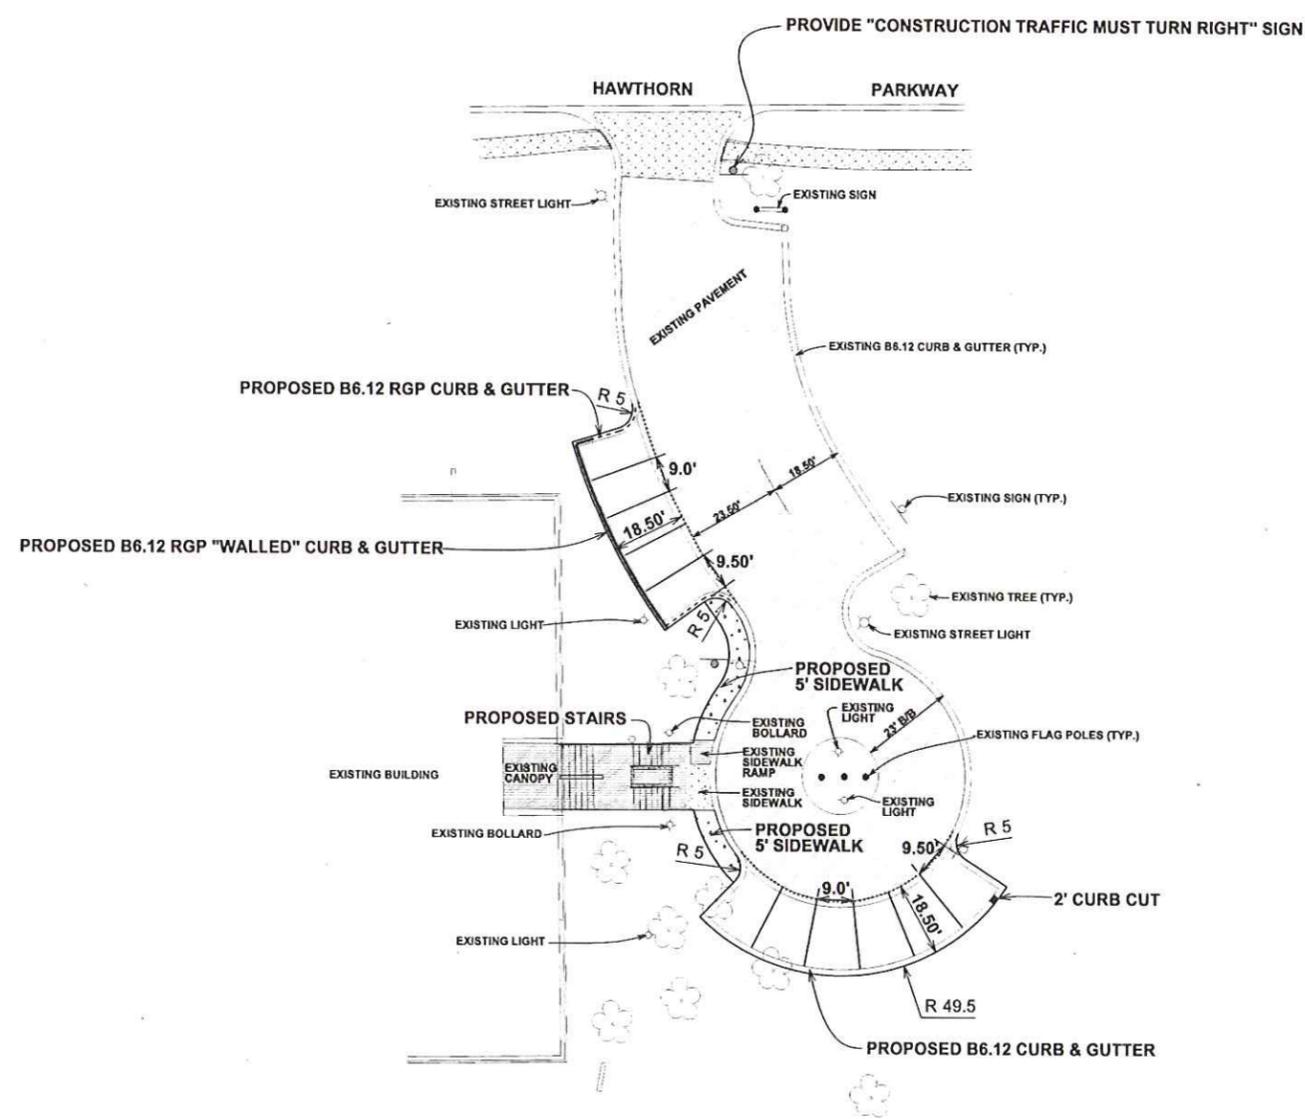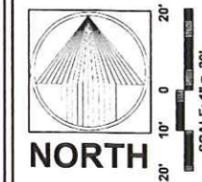

NOTE:
 THE NEW PAVEMENT STRIPING SHALL BE 4" YELLOW
 - TWO COATS OF TRAFFIC MARKING PAINT

RUST-OLEUM CORPORATION
 VERNON HILLS, ILLINOIS

PEARSON, BROWN & ASSOCIATES, INC.
 CONSULTING ENGINEERS
 1850 W. WINCHESTER ROAD - SUITE 205
 LITTLETON, CO 80120
 PHONE: (847) 357-2877
 FAX: (847) 357-2887
 E-MAIL ADDRESS: pba@pearsonbrown.com

DESIGNED BY: G.A.Z.
 DRAWN BY: R.C.J.
 CHECKED BY: J.F.C.
 ORIGINAL ISSUE: 05/20/11

DATE BY: 05/23/11 DSM
 DESCRIPTION: REVISED SIDEWALK PER OWNER

REVISIONS

GEOMETRICS PLAN

Principle
 CONSULTING ENGINEERS
 1801 Lakewood Drive, Suite 200
 Burr Ridge, IL 60511
 630.708.1313
 630.708.1308 FAX

SHEET NUMBER


3

OF 5 SHEETS

JOB No. 1124

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ILLINOIS SOIL EROSION AND SEDIMENTATION CONTROL MEASURE SELECTION PROCESS

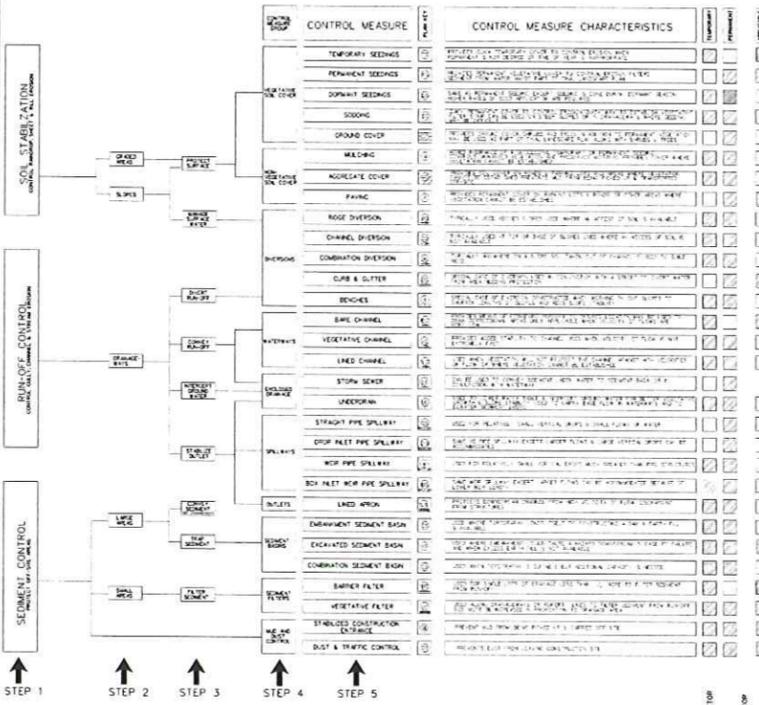

STEPS IN THE SELECTION OF CONTROL MEASURES


STEP 1: IDENTIFY CONTROL PROBLEM
 On any construction site the objective is to prevent or minimize erosion and sedimentation. The three basic methods used to control erosion and sedimentation are: 1) prevent erosion, 2) control erosion, and 3) remove sediment. The selection of control measures should be based on the type of erosion and sedimentation problem. The selection of control measures should be based on the type of erosion and sedimentation problem. The selection of control measures should be based on the type of erosion and sedimentation problem.

STEP 2: IDENTIFY CONTROL MEASURES
 Once a method of control is selected, the next step is to identify the control measures. The selection of control measures should be based on the type of erosion and sedimentation problem. The selection of control measures should be based on the type of erosion and sedimentation problem. The selection of control measures should be based on the type of erosion and sedimentation problem.

STEP 3: IDENTIFY REQUIRED STRATEGY
 The next step in the selection process is to identify the required strategy. The selection of control measures should be based on the type of erosion and sedimentation problem. The selection of control measures should be based on the type of erosion and sedimentation problem. The selection of control measures should be based on the type of erosion and sedimentation problem.

STEP 4: IDENTIFY CONTROL MEASURE GROUP
 Once the required strategy is identified, the next step is to identify the control measure group. The selection of control measures should be based on the type of erosion and sedimentation problem. The selection of control measures should be based on the type of erosion and sedimentation problem. The selection of control measures should be based on the type of erosion and sedimentation problem.

STEP 5: SELECT SPECIFIC CONTROL MEASURE
 The final step in the selection process is to select the specific control measure. The selection of control measures should be based on the type of erosion and sedimentation problem. The selection of control measures should be based on the type of erosion and sedimentation problem. The selection of control measures should be based on the type of erosion and sedimentation problem.

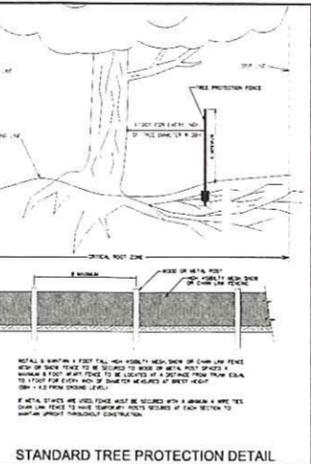

SEDIMENTATION AND EROSION CONTROL NOTES

- SOIL DISTURBANCE SHALL BE CONDUCTED IN SUCH A MANNER AS TO MINIMIZE EROSION. SOIL STABILIZATION MEASURES SHALL BE INITIATED AS SOON AS PRACTICABLE AND THE USE OF TEMPORARY OR PERMANENT MEASURES.
- SOIL EROSION AND SEDIMENT CONTROL FEATURES SHALL BE CONSTRUCTED PRIOR TO THE COMMENCEMENT OF HYDROLOGIC DISTURBANCE OF UPLAND AREAS.
- EXCEPT AS PROVIDED BELOW, STABILIZATION MEASURES SHALL BE INITIATED AS SOON AS PRACTICABLE IN THOSE PORTIONS OF THE SITE WHERE CONSTRUCTION ACTIVITIES ARE TEMPORARILY OR PERMANENTLY CEASED, BUT IN NO CASE MORE THAN 14 DAYS AFTER CONSTRUCTION ACTIVITY IN THAT PORTION OF THE SITE HAS TEMPORARILY OR PERMANENTLY CEASED.
 - WHERE THE INITIATION OF STABILIZATION MEASURES BY THE 7TH DAY AFTER CONSTRUCTION ACTIVITY TEMPORARILY OR PERMANENTLY CEASES IS PRECLUDED BY SNOW COVER, STABILIZATION MEASURES SHALL BE INITIATED AS SOON AS PRACTICABLE.
 - WHERE CONSTRUCTION ACTIVITY WILL RESUME ON A PORTION OF THE SITE WITHIN 14 DAYS FROM WHEN ACTIVITIES CEASED, E.G. THE TOTAL TIME PERIOD THAT CONSTRUCTION ACTIVITY IS TEMPORARILY CEASED IS LESS THAN 14 DAYS, THEN STABILIZATION MEASURES DO NOT HAVE TO BE INITIATED ON THAT PORTION OF SITE BY THE 7TH DAY AFTER CONSTRUCTION ACTIVITY TEMPORARILY CEASES.
- AREAS OR EMBANKMENTS HAVING SLOPES GREATER THAN OR EQUAL TO 3H:1V SHALL BE STABILIZED WITH SOO, MAT, OR BLANKET IN COMBINATION WITH SEEDING.
- EROSION CONTROL BLANKET SHALL BE REQUIRED ON ALL INTERIOR DETENTION BASIN SIDE SLOPES BETWEEN THE NORMAL WATER LEVEL AND HIGH WATER LEVEL.
- ALL STORM SEWERS THAT ARE OR WILL BE FUNCTIONING DURING CONSTRUCTION SHALL BE PROTECTED BY AN APPROPRIATE SEDIMENT CONTROL MEASURE.
- ALL TEMPORARY EROSION AND SEDIMENT CONTROL MEASURES SHALL BE REMOVED WITHIN 30 DAYS AFTER FINAL SITE STABILIZATION IS ACHIEVED OR AFTER THE TEMPORARY MEASURES ARE NO LONGER NEEDED.
- ALL TEMPORARY AND PERMANENT EROSION CONTROL MEASURES MUST BE MAINTAINED AND REPAIRED AS NEEDED. THE PROPERTY OWNER SHALL BE ULTIMATELY RESPONSIBLE FOR MAINTENANCE AND REPAIRS.
- A STABILIZED MAT OF AGGREGATE UNDERLAIN WITH FILTER CLOTH OR OTHER APPROPRIATE MEASURES SHALL BE LOCATED AT ANY POINT WHERE TRAFFIC WILL BE ENTERING OR LEAVING A CONSTRUCTION SITE FROM A PUBLIC HIGHWAY, STREET, ALLEY OR PARKING AREA. ANY SEDIMENT OR SOIL REACHING AN IMPROVED PUBLIC RIGHT-OF-WAY, STREET, ALLEY OR PARKING AREA SHALL BE REMOVED BY SCRAPING OR BY CLEANING OR BY OTHER MEANS AS WARRANTED AND TRANSPORTED TO A CONTROLLED SEDIMENT DISPOSAL AREA.
- SOIL STOCKPILES SHALL NOT BE LOCATED IN A FLOOD-PRONE AREA OR A DESIGNATED WETLAND BUFFER.
- IF DITCHING SERVICES ARE USED, ADJOINING PROPERTIES AND DISCHARGE LOCATIONS SHALL BE PROTECTED FROM EROSION. DISCHARGES SHALL BE ROUTED THROUGH AN EFFECTIVE SEDIMENT CONTROL MEASURE (e.g. SEDIMENT TRAP, SEDIMENT BASIN, OR OTHER APPROPRIATE MEASURE).
- THE EROSION CONTROL MEASURES INDICATED ON THE PLANS ARE THE MINIMUM REQUIREMENTS. ADDITIONAL MEASURES MAY BE REQUIRED AS DIRECTED BY THE ENGINEER OR GOVERNING AGENCY.

TYPICAL CONSTRUCTION SEQUENCING

- INSTALLATION OF SOIL EROSION AND SEDIMENT CONTROL SE/SC MEASURES
- SILT FENCE INSTALLATION
- CONSTRUCTION FENCING AROUND AREAS NOT TO BE DISTURBED
- STABILIZED CONSTRUCTION ENTRANCE
- TREE REMOVAL WHERE NECESSARY (CLEAR A GRUB)
- CONSTRUCT SEDIMENT TRAPPING DEVICES (SEDIMENT TRAPS, BASINS...)
- CONSTRUCT DETENTION FACILITIES AND OUTLET CONTROL STRUCTURE WITH RESTRICTOR & TEMPORARY PERFORATED RISER
- STRIP TOPSOIL, STOCKPILE TOPSOIL AND GRADE SITE
- TEMPORARILY STABILIZE TOPSOIL STOCKPILES (SEED AND SILT FENCE AROUND FOOT OF SLOPE)
- INSTALL STORM SEWER, SANITARY SEWER, WATER AND ASSOCIATED INLET & OUTLET PROTECTION
- PERMANENTLY STABILIZE DETENTION BASINS WITH SEED AND EROSION CONTROL BLANKET
- TEMPORARILY STABILIZE ALL AREAS INCLUDING LOTS THAT HAVE REACHED TEMPORARY GRADE
- INSTALL ROADWAYS
- PERMANENTLY STABILIZE ALL OUTLET AREAS
- INSTALL STRUCTURES AND GRADE INDIVIDUAL LOTS
- PERMANENTLY STABILIZE LOTS
- REMOVE ALL TEMPORARY SE/SC MEASURES AFTER THE SITE IS STABILIZED WITH VEGETATION
- SOIL EROSION AND SEDIMENT CONTROL MAINTENANCE MUST OCCUR WEEKLY AND AFTER EVERY ONE-HALF INCH (1/2") OR GREATER RAINFALL EVENT




PROOF ROLLING OF THE SUBGRADE AND SUBBASE SHALL MEET THE VILLAGE OF VERNON HILLS CODE OF ORDINANCES APPENDIX B, DEVELOPMENT REGULATIONS SECTION H REQUIREMENTS.

SOIL PROTECTION CHART

STABILIZATION TYPE	JAN	FEB	MAR	APR	MAY	JUNE	JULY	AUG	SEP	OCT	NOV	DEC
PERMANENT SEEDING				A								
DORMANT SEEDING												B
TEMPORARY SEEDING				C								
SOODING												
MAIDING												

CONSTRUCTION SEQUENCE & RESPONSIBLE CONTRACTOR

CONSTRUCTION SEQUENCE	GRADING CONTRACTOR	UNDERGROUND CONSTRUCTION CONTRACTOR	PAVING CONTRACTOR	LANDSCAPING CONTRACTOR
1. INSTALL SEDIMENT CONTROL	<input type="checkbox"/>	<input type="checkbox"/>	<input type="checkbox"/>	<input type="checkbox"/>
ROCK DIVERSION	<input type="checkbox"/>	<input type="checkbox"/>	<input type="checkbox"/>	<input type="checkbox"/>
COMBINATION DIVERSION	<input type="checkbox"/>	<input type="checkbox"/>	<input type="checkbox"/>	<input type="checkbox"/>
VEGETATIVE CHANNEL	<input type="checkbox"/>	<input type="checkbox"/>	<input type="checkbox"/>	<input type="checkbox"/>
STRAIGHT PIPE SPILLWAY	<input type="checkbox"/>	<input type="checkbox"/>	<input type="checkbox"/>	<input type="checkbox"/>
DROP PIPE SPILLWAY	<input type="checkbox"/>	<input type="checkbox"/>	<input type="checkbox"/>	<input type="checkbox"/>
INLET SPILLWAY	<input type="checkbox"/>	<input type="checkbox"/>	<input type="checkbox"/>	<input type="checkbox"/>
ROCK INLET NEAR PIPE SPILLWAY	<input type="checkbox"/>	<input type="checkbox"/>	<input type="checkbox"/>	<input type="checkbox"/>
LINED APRON	<input type="checkbox"/>	<input type="checkbox"/>	<input type="checkbox"/>	<input type="checkbox"/>
EMBEDDED SEDIMENT BASIN	<input type="checkbox"/>	<input type="checkbox"/>	<input type="checkbox"/>	<input type="checkbox"/>
EXCAVATED SEDIMENT BASIN	<input type="checkbox"/>	<input type="checkbox"/>	<input type="checkbox"/>	<input type="checkbox"/>
COMBINATION SEDIMENT BASIN	<input type="checkbox"/>	<input type="checkbox"/>	<input type="checkbox"/>	<input type="checkbox"/>
BARBED FILTER	<input type="checkbox"/>	<input type="checkbox"/>	<input type="checkbox"/>	<input type="checkbox"/>
STABILIZED CONSTRUCTION ENTRANCE	<input type="checkbox"/>	<input type="checkbox"/>	<input type="checkbox"/>	<input type="checkbox"/>
DUST & TRAFFIC CONTROL	<input type="checkbox"/>	<input type="checkbox"/>	<input type="checkbox"/>	<input type="checkbox"/>

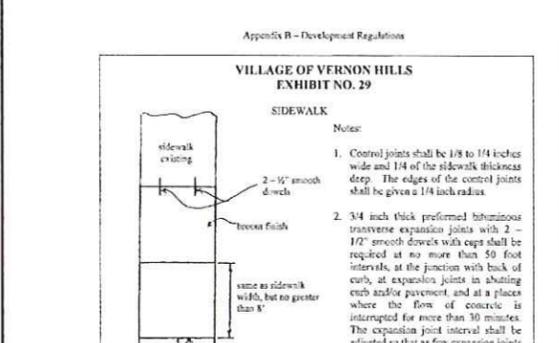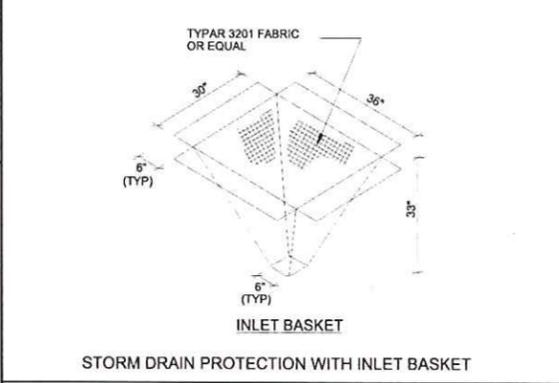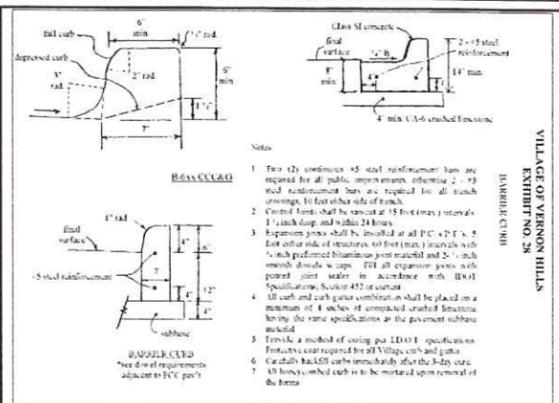

PROOF ROLLING OF THE SUBGRADE AND SUBBASE SHALL MEET THE VILLAGE OF VERNON HILLS CODE OF ORDINANCES APPENDIX B, DEVELOPMENT REGULATIONS SECTION H REQUIREMENTS.

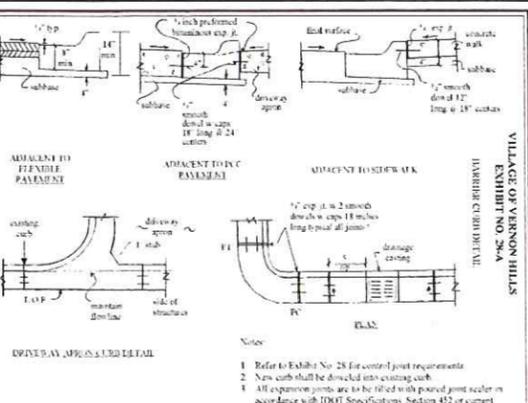


TABLE INSET

Structural Number Required	Minimum Thickness (inches)	Surface Layer (inches)
2.00-3.00	1.50	1.50
3.01-3.99	2.00	1.50
4.00-4.99	2.50	1.50
5.00-5.99	3.00	1.50
6.00-6.99	3.50	1.50
7.00-7.99	4.00	1.50
8.00-8.99	4.50	1.50

TABLE INSET

Material	Strength Requirements (M.S. BR. F.B.)	Structural Layer Coefficient
Blunt-topped surface		
Class I	1700	0.80
Class II	1500	0.70
Class III	1300	0.60
Class IV	1100	0.50
Class V	900	0.40
Class VI	700	0.30
Class VII	500	0.20
Class VIII	300	0.10

TABLE INSET

Material	Strength Requirements (M.S. BR. F.B.)	Structural Layer Coefficient
Blunt-topped surface		
Class I	1700	0.80
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Class III	1300	0.60
Class IV	1100	0.50
Class V	900	0.40
Class VI	700	0.30
Class VII	500	0.20
Class VIII	300	0.10

VILLAGE OF VERNON HILLS PAVEMENT SPECIFICATIONS

1-1/2" H.M.A. SURFACE COURSE MIX 'C', N50
 2-1/4" H.M.A. BINDER COURSE IL19.0, N50
 7-1/2" CA-6 CRUSHED LIMESTONE AGGREGATE BASE COURSE

PARKING LOT PAVEMENT DESIGN

RUST-OLEUM CORPORATION
 VERNON HILLS, ILLINOIS

PEARSON, BROWN & ASSOCIATES, INC.
 CONSULTING ENGINEERS
 1850 W. WINCHESTER ROAD - SUITE 305
 LOMBARD, ILLINOIS 60148
 PHONE: (630) 367-8970
 FAX: (630) 367-2587
 E-MAIL ADDRESS: pba@pearsonbrown.com
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DESIGNED BY: G.A.Z.
 DRAWN BY: R.C.L.
 CHECKED BY: J.E.C.
 ORIGINAL ISSUE: 05/20/11

Principle
 4801 Lakeville Drive, Suite 400
 Burr Ridge, IL 60511
 630.581.1515
 630.581.1516

DETAILS

REVISIONS

DATE	DESCRIPTION

SHEET NUMBER
 5
 OF 5 SHEETS

JOB NO. 1124

STATE OF ILLINOIS)
)
COUNTY OF LAKE)

CERTIFICATE

I, MICHAEL S. ALLISON, CERTIFY THAT I AM THE DULY APPOINTED AND VILLAGE CLERK OF THE VILLAGE OF VERNON HILLS, LAKE COUNTY, ILLINOIS. I FURTHER CERTIFY THAT ON JULY 6, 2011, THE CORPORATE AUTHORITIES OF SUCH MUNICIPALITY PASSED AND APPROVED ORDINANCE 2011-037, AN ORDINANCE AMENDING THE FINAL SITE AND LANDSCAPING PLAN APPROVALS FOR THE PROPOSED EAST PARKING LOT EXPANSION PLAN FOR PROPERTY LOCATED AT 11 EAST HAWTHORN PARKWAY, IN THE VILLAGE OF VERNON HILLS, LAKE COUNTY

THE PAMPHLET FOR ORDINANCE NO. 2010-037, INCLUDING THE ORDINANCE AND A COVER SHEET THEREOF WAS PREPARED, AND A COPY OF SUCH ORDINANCE WAS POSTED IN THE VILLAGE HALL, COMMENCING JULY 12, 2011 AND CONTINUING FOR AT LEAST TEN DAYS THEREAFTER. COPIES OF SUCH ORDINANCE WERE ALSO AVAILABLE FOR PUBLIC INSPECTION UPON REQUEST IN THE OFFICE OF THE VILLAGE CLERK.

DATED IN VERNON HILLS, ILLINOIS, THIS 12TH DAY OF JULY, 2011




MICHAEL S. ALLISON, VILLAGE CLERK

SEAL

AFFIDAVIT OF SERVICE

STATE OF ILLINOIS)
)
COUNTY OF LAKE)

I, MICHAEL S. ALLISON, BEING FIRST DULY APPOINTED, DEPOSES AND SAYS ON OATH THAT AS VILLAGE CLERK OF THE VILLAGE OF VERNON HILLS, HE DID CAUSE THE FOREGOING CERTIFICATE FOR ORDINANCE 2011-037, AN ORDINANCE AMENDING THE FINAL SITE AND LANDSCAPING PLAN APPROVALS FOR THE PROPOSED EAST PARKING LOT EXPANSION PLAN FOR PROPERTY LOCATED AT 11 EAST HAWTHORN PARKWAY, IN THE VILLAGE OF VERNON HILLS, LAKE COUNTY

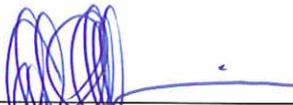

MICHAEL S. ALLISON, VILLAGE CLERK

SUBSCRIBED AND SWORN TO BEFORE
THIS 12TH DAY OF JULY, 2011



Notary Public

